

NEW PAVILION AND SITE IMPROVEMENTS 715 CAMPUS ST MILTON, WI

Angus Young Architecture
Engineering
Interior Design
Balance in Creativity

555 South River Street Janesville, WI 53548-4783
Ph: 608.756.2326 Fx: 608.756.0464
www.angusyong.com



CONCEPTUAL RENDERING - OVERALL



CONCEPTUAL RENDERING - PAVILION



CONCEPTUAL RENDERING - PERGOLA



CONCEPTUAL RENDERING - CONCESSIONS

REGULATORY DATA

PROJECT ADDRESS
715 CAMPUS ST
MILTON, WI

BUILDING CODE
2015 IBC

GENERAL BUILDING HEIGHT AND AREA
MAXIMUM AREA = 5,500 SQ. FT.
MAXIMUM STORIES = ONE

CONCESSION BUILDING = 990 SQ. FT.
PAVILLION = 1,370 SQ. FT.
PERGOLA = 250 SQ. FT.

STORIES = ALL BUILDINGS = 1

USE AND OCCUPANCY CLASSIFICATION
U - UTILITY AND MISC.

TYPE OF CONSTRUCTION
TYPE VB
UNSPRINKLERED

SHEET INDEX

GENERAL
G001 COVER SHEET AND REGULATORY INFORMATION

CIVIL (BATTERMAN ENGINEERING)
1 OF 15 BATTERMAN COVERSHEET
2 OF 15 EXISTING CONDITIONS
3 OF 15 REMOVALS PLAN
4 OF 15 OVERALL SITE LAYOUT
5 OF 15 ENLARGED SITE LAYOUT
6 OF 15 OVERALL GRADING PLAN
7 OF 15 ENLARGED GRADING PLAN
8 OF 15 STORM DRAINAGE PLAN
9 OF 15 EROSION CONTROL NOTES
10 OF 15 EROSION CONTROL PLAN
11 OF 15 EROSION CONTROL DETAILS
12 OF 15 DETAILS
13 OF 15 DETAILS
14 OF 15 DETAILS
15 OF 15 DETAILS

LANDSCAPING
C801 LANDSCAPE PLAN AND DETAILS
C801 SITE DETAILS
ES01 SITE LIGHTING

ARCHITECTURAL
A101 CONCESSIONS PLAN AND EXTERIOR ELEVATIONS
A102 PAVILLION FLOOR PLAN AND ELEVATIONS
A103 PERGOLA FLOOR PLAN AND ELEVATIONS
A301 DOOR, HARDWARE, AND MATERIAL SCHEDULES
A801 BUILDING SECTIONS
A801 ARCHITECTURAL DETAILS

STRUCTURAL
S101 CONCESSIONS AND PERGOLA FOUNDATION AND SLAB PLAN
S301 PAVILLION FOUNDATION AND SLAB PLAN
S201 CONCESSIONS AND PERGOLA ROOF FRAMING PLANS
S202 PAVILLION ROOF FRAMING PLAN
S301 GENERAL NOTES AND SPECIFICATIONS
S801 STRUCTURAL DETAILS

MECHANICAL
M101 MECHANICAL PLAN

PLUMBING
P101 UNDERGROUND/ABOVEGROUND PLUMBING PLANS

ELECTRICAL
E101 CONCESSION AND PAVILLION ELECTRICAL PLAN
E301 ELECTRICAL SCHEDULES
ES01 ELECTRICAL SITE PLAN
ES11 SITE LIGHTING PHOTOMETRIC CALCULATIONS

SYMBOL LEGEND

100 DOOR NUMBER 100 SYMBOL REFERENCE DOOR SCHEDULE FOR SIZE AND TYPE OF DOOR

100 ROOM NUMBER 100 SYMBOL REFERENCE ROOM FINISH SCHEDULE FOR FINISHES

ELEVATION MARK ELEV. TO TOP

DIMENSION TO FINISH (EXISTING OR NEW)

DIMENSION TO CENTERLINE (COL. OR WALL)

DIMENSION TO NOMINAL MATERIAL

ILLUMINATED EXIT SIGN

B.F. BARRIER FREE FIXTURE SEE BARRIER FREE MOUNTING SCHEDULE FOR INFORMATION

MATERIAL SYMBOL LEGEND

UNDISTURBED EARTH	COMPACTED FILL	METAL	CONCRETE BLOCK	PLYWOOD	ACOUSTICAL TILE
WOOD (BLOCKING)	BATT INSULATION	WOOD (ROUGH)	WOOD (FINISH)	LIGHTWEIGHT CONCRETE	BRICK
SAND	GLASS	CERAMIC TILE	GYP/SUM BOARD	STONE OR MARBLE	GRAVEL
RIGID INSULATION	FLOOR TILE	PLASTER	METAL STUD	PLASTIC	GLASS BLOCK

24	20	16	12	08	04
23	19	15	11	07	03
22	18	14	10	06	02
21	17	13	09	05	01

TITLE BLOCK

06.02.2020

REGISTRATION STAMP AND SIGNATURE

NEW PAVILION AND SITE IMPROVEMENTS THE GATHERING PLACE

PROJECT NUMBER: 67220
APPROVED BY: JJS

REVIEWED BY: JJS
DRAWN BY: AYA

ISSUANCES: 06/02/2020
STATE BUILDING REVIEW - 06/02/2020
QUALITY ASSURANCE - 06/12/2020
CITY SUBMITTAL - 07/01/2020

REVISIONS:

7/1/2020 8:30:57 AM

G001

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SCALE: 1/8" = 1'-0"
PLOTTED BY: ksh

ORIGINAL SIZE: 24" x 36"
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LANDSCAPE PLANT LEGEND						
SYMBOL	BOTANICAL NAME	COMMON NAME	INSTALLED SIZE	ROOT	MATURE SIZE	QTY
TREES:						
AF	<i>Acer x freemanii</i> 'Autumn Fantasy'	Autumn Fantasy Freeman Maple	2" Cal	B.B.	45' H x 35' W	3
GT	<i>Gleditsia triacanthos</i> var. <i>inermis</i> 'Skyline'	Skyline Honeylocust	2" Cal.	B.B.	50' H x 30' W	6
JC	<i>Juniperus chinensis</i> 'Mountbatten'	Mountbatten Juniper	5' High	B.B.	15' H x 6-8' W	22

LANDSCAPE REQUIREMENTS - COMMERCIAL PROPERTY

Street Tree Requirement:

Provide 1 large deciduous tree for every 100' of street frontage.

Street	Street Frontage	Calculation	Trees Required	Existing Trees to Remain	New Street Trees
Rogers Street	397 lf	1 / 100 LF	4	14	0
E. St. Mary Street	219 lf	1 / 100 LF	2	0	2

Paved Area Landscaping:

Provide 1 large deciduous tree and 30 points of additional landscaping for each 2,250 sf of paving (including walkways). Plantings shall be planted within 15' of paved areas.

	Area	Required Trees	Required Landscape Points
Paved Surface Area	24,302 sf	11	324

Provided Landscaping

Plant	Point Value	Quantity	Provided Landscape Points
Large Deciduous Tree (Mature 25+ H), 2" Cal. & Existing	150	11	not included in total
Evergreen Tree (min. 5' High)	60	16	960
Subtotal			960

Building Foundation Plantings:

Provide 150 landscape points per 100 lf of building foundation. Must be planted within 20' of building foundation and may not include large deciduous trees.

	Perimeter	Calculation	Required Landscape Points
Building Foundation Perimeter - Pavilion	407 lf	150 pts/100 LF	611

Provided Landscaping

Plant	Point Value	Quantity	Provided Landscape Points
Evergreen Tree (min. 5' High)	60	12	720
Subtotal			720

	Perimeter	Calculation	Required Landscape Points
Building Foundation Perimeter - Concession Stand	625 lf	150 pts/100 LF	938



Provided Landscaping

Plant	Point Value	Quantity	Provided Landscape Points
Large Deciduous Tree (Mature 25+ H), 2" Cal.	150	7	1050
Subtotal			1050


Note: In lieu of foundation plantings around concession stand, shade trees on site have been provided.

Buffer Yards:

Providing evergreen buffer along east side of pavilion

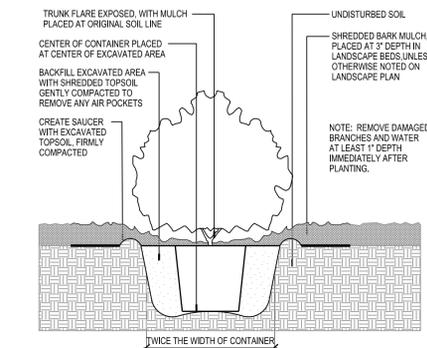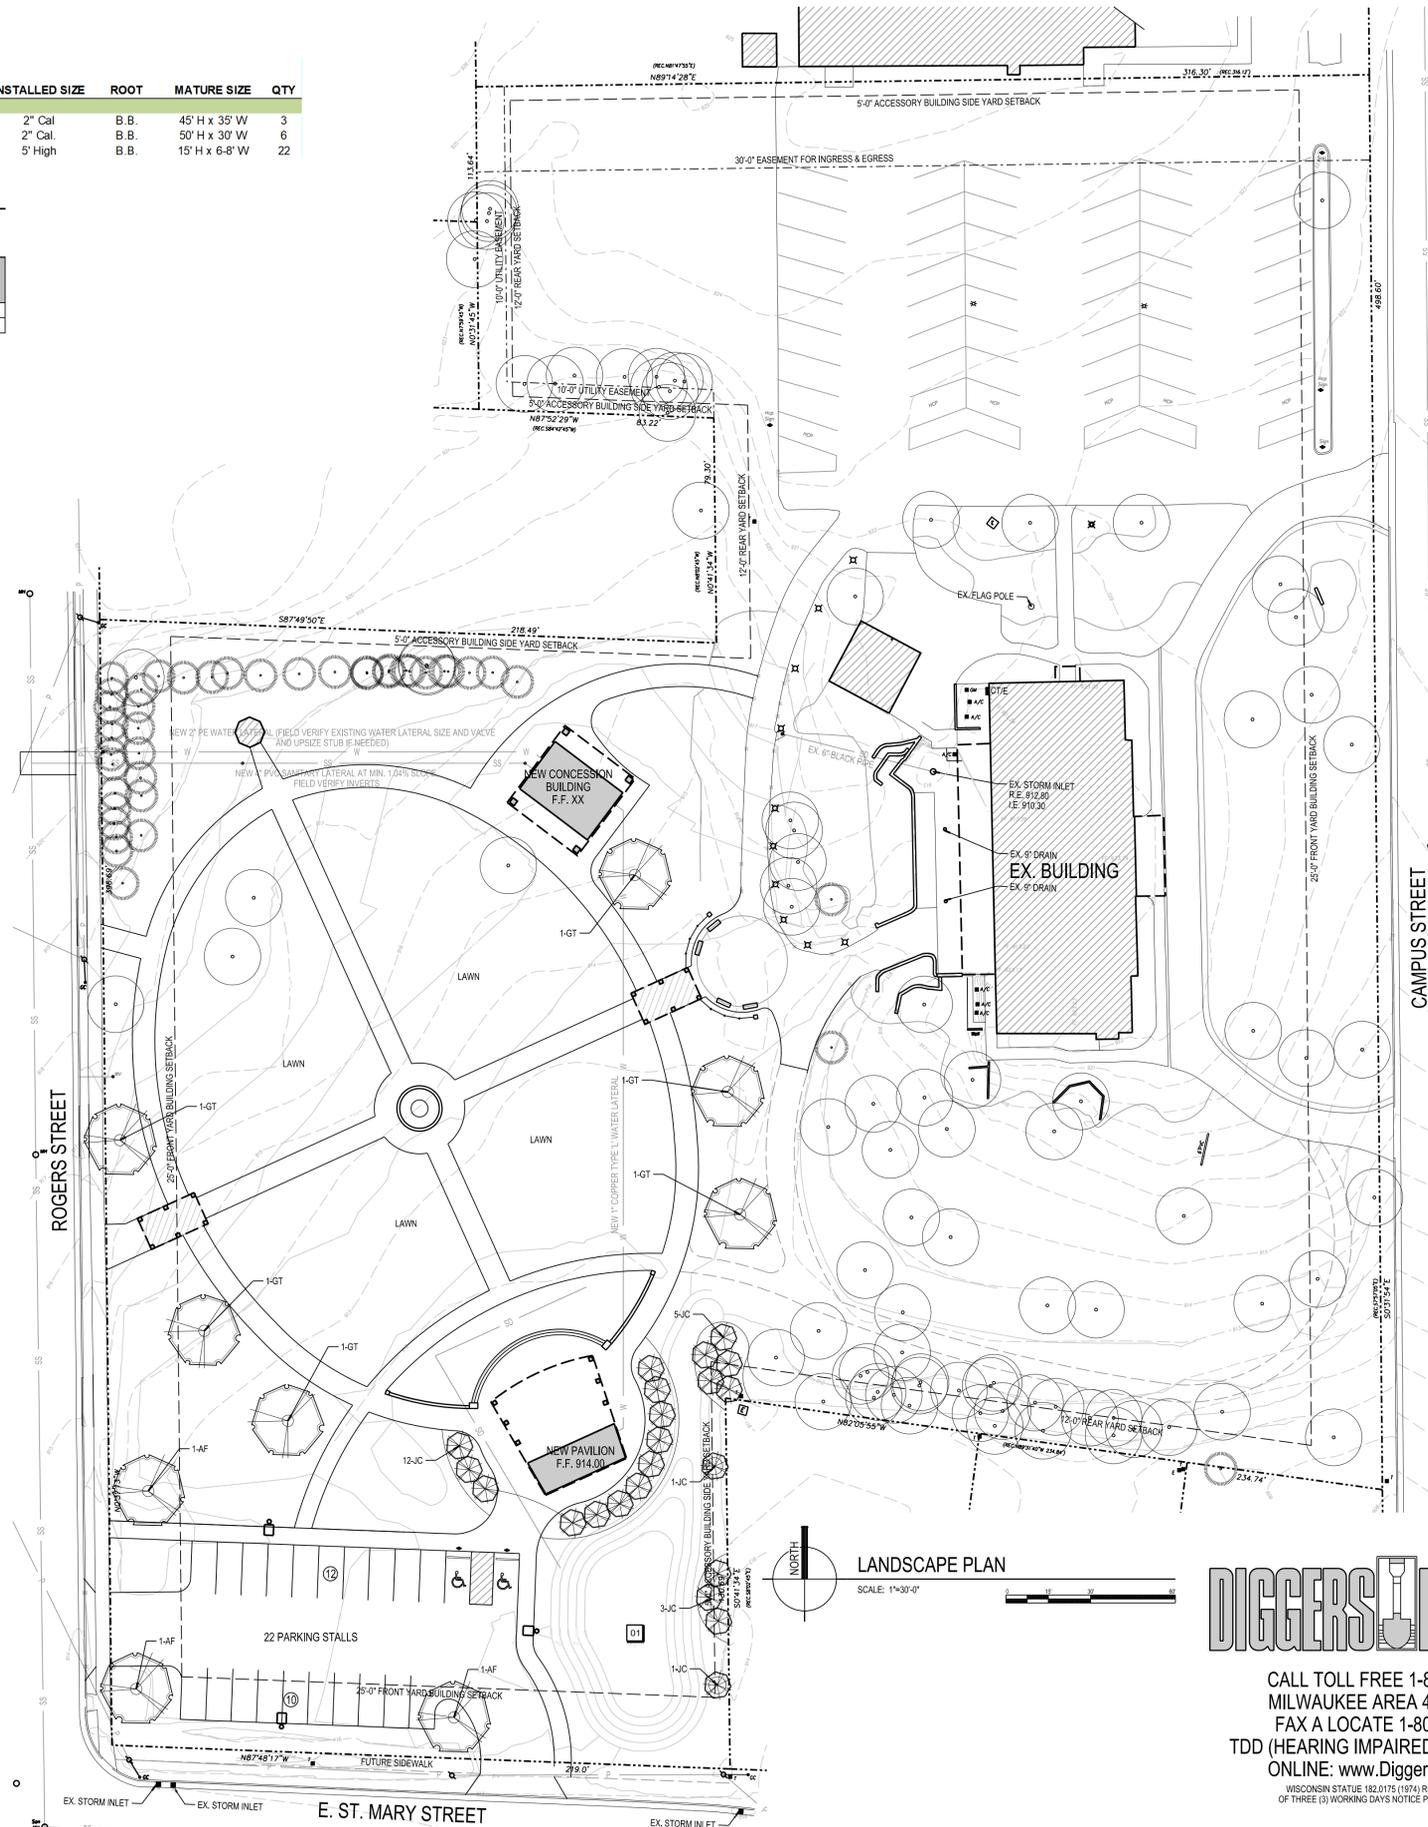

04 CONTAINER PLANTING IN LANDSCAPE BED
SCALE: 1"=1'0"

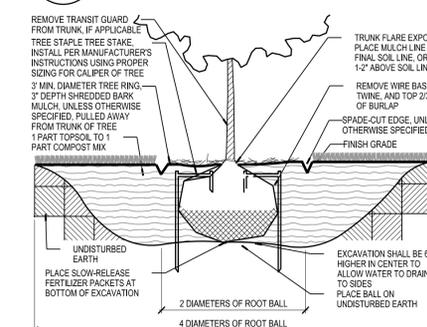

03 B.B. SHRUB AND TREE PLANTING DETAIL
SCALE: NONE

04 CONTAINER PLANTING IN LANDSCAPE BED
SCALE: 1"=1'0"

LANDSCAPE SYMBOL LEGEND		
		SHADE TREE
		ORNAMENTAL TREE
		EVERGREEN SHRUB OR TREE
		DECIDUOUS SHRUB
		ORNAMENTAL GRASS
		PERENNIAL
		EXISTING VEGETATION
		EXISTING EVERGREEN

NOTE: ALL SYMBOLS MAY NOT BE USED IN THIS SET.

KEYNOTES
01 NEW INFILTRATION BASIN PLUG PLANTING. INSTALL COVERING 90% CONTOUR AREA. PROVIDE AGRECUL RAINWATER RENEWAL GARDEN FOR SUNNY SITES AT 64 PLANTS PER 125 SF (-13 KITS) PLUS 16 PLUGS OF ASCLEPIAS INCARNATA

LANDSCAPE GENERAL NOTES
 1. TRUE NORTH MAY VARY FROM PROJECT NORTH.
 2. CONSTRUCTION PRACTICES, MEANS AND METHODS, AND JOB SITE SAFETY, SHALL REMAIN THE SOLE RESPONSIBILITY OF THE CONTRACTOR.
 3. FIELD VERIFY ALL EXISTING AND PROPOSED UTILITIES, ELEVATIONS AND DIMENSIONS.
 4. DIGGERS HOTLINE SHALL BE CALLED TO MARK UTILITIES PRIOR TO LAND DISTURBANCE.
 5. RESTORE ALL AREAS TO SEEDING LAWN UNLESS NOTED OTHERWISE.
 6. IN THE EVENT THAT QUANTITY DISCREPANCIES OR MATERIAL OMISSIONS OCCUR IN THE PLANT MATERIALS LIST, THE PLANTING PLANS SHALL GOVERN.
 7. ALL INDIVIDUAL TREES SHALL RECEIVE 4" DIAMETER, 3" THICK SHREDDED BARK MULCH TREE RING WITH SPADE CUT EDGE. MULCH SHALL BE PULLED AWAY FROM TRUNK OF TREE TO PREVENT ROT.
 8. ALL LAWN TO BE RESTORED WITH SEED AND EROSION MAT OR HYDROMULCH UNLESS NOTED OTHERWISE. WOODSLOT URBAN TYPE B EROSION MAT SHALL BE PROVIDED ON SLOPES 4:1 OR GREATER.
 9. INFILTRATION BASIN SHALL RECEIVE CLASS II EROSION MAT (COCONUT MAT ERONET C125 OR EQUIVALENT). MAT SHALL BE INSTALLED WITH OVERLAPPED JOINTS AND STAKED WITH HARDWOOD STAKES MIN. 6" LONG PRIOR TO INSTALLATION OF PLANTS TO PREVENT COMPRESSION.
 10. SEE DETAILS 03C01 AND 04C01 FOR PLANTING DETAILS.

SCALE: 1"=30'-0"
 PLOTTED BY: kshlu
 ORIGINAL SIZE: 24" x 36"
 X:\27220\06167206\06167206.dgn



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PROJECT NUMBER: 67220
 APPROVED BY: JAS
 REVIEWED BY: JAS
 DRAWN BY: KAU
 7/1/2020 8:13:03 AM

LANDSCAPE PLAN AND DETAILS

C601


STATE BUILDING REVIEW SUBMITTAL - 06/02/2020

ISSUANCES


REVISIONS

NEW PAVILION AND SITE IMPROVEMENTS THE GATHERING PLACE MILTON, WI


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 PLOTTED BY: kahu

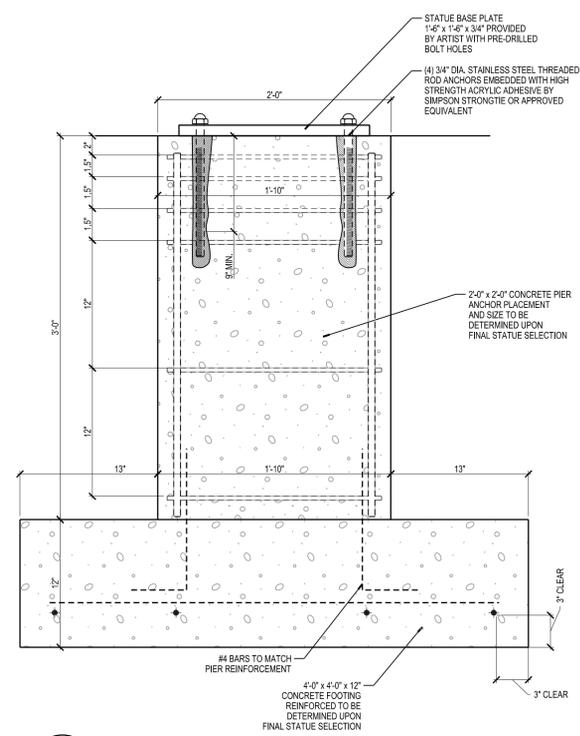


19 WIND SCULPTURE BASE DETAIL
 C801 SCALE: 1/12"=1'-0"

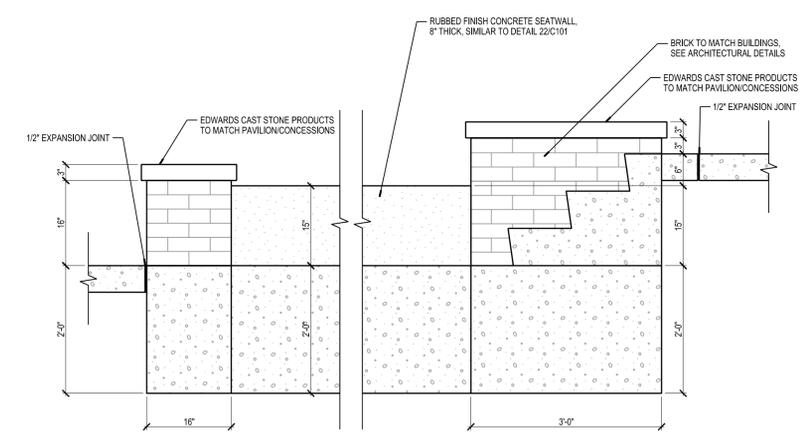


11 STAGE SEATWALL AND BRICK PIER DETAILS
 C801 SCALE: 3/4"=1'-0"

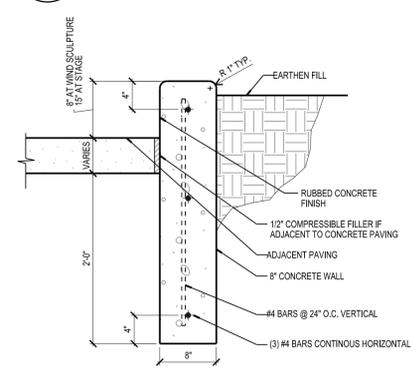


18 PLANTER WALL SECTION
 C801 SCALE: 1"=1'-0"

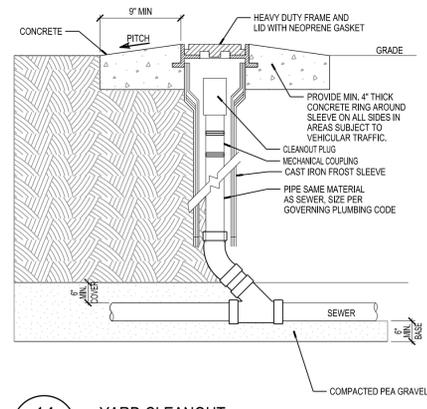


14 YARD CLEANOUT
 C801 SCALE: NONE

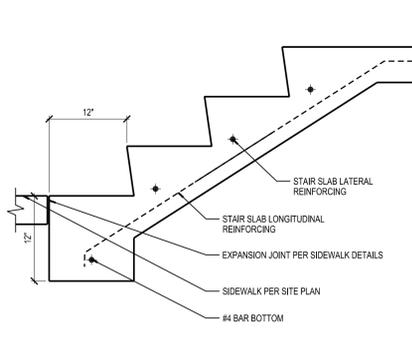

17 CONCRETE STAIR SECTION DETAIL
 C801 SCALE: 1"=1'-0"

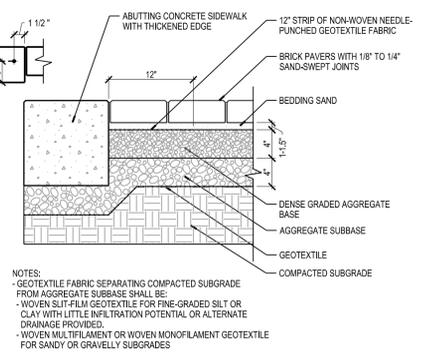

13 BRICK PAVERS ON AGGREGATE BASE
 C801 SCALE: 1"=1'-0"

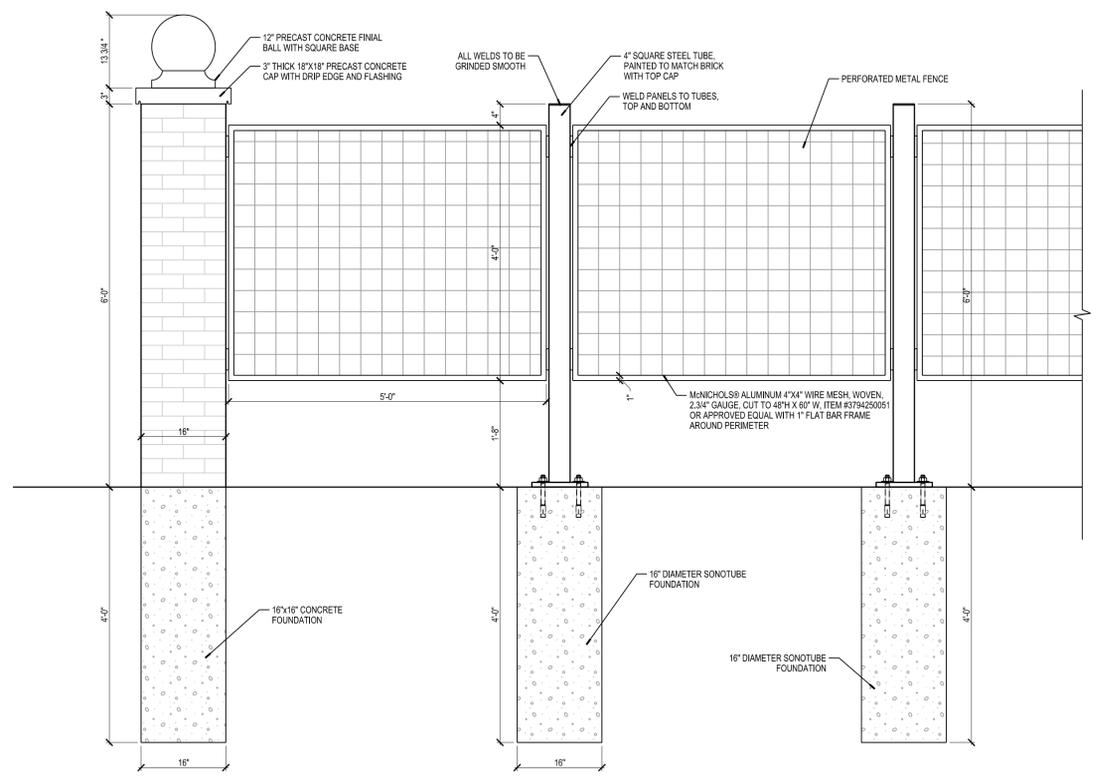

09 DECORATIVE FENCE PANEL DETAIL
 C801 SCALE: 3/4"=1'-0"


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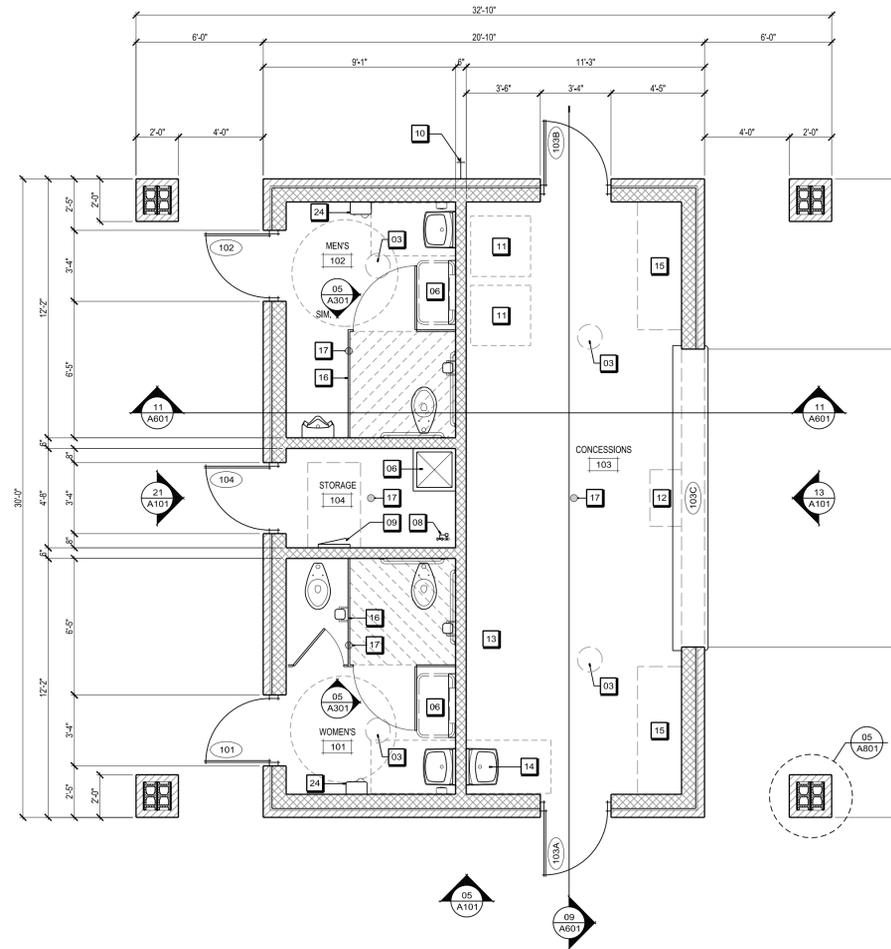
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 THE GATHERING PLACE
 MILTON, WI

PROJECT NUMBER: 67220
 APPROVED BY: JAS
 REVIEWED BY: JAS
 DRAWN BY: KAU
 7/1/2020 8:13:17 AM
 SITE DETAILS




21 CONCESSIONS ROOF FRAMING PLAN
SCALE: 1/8" = 1'-0"

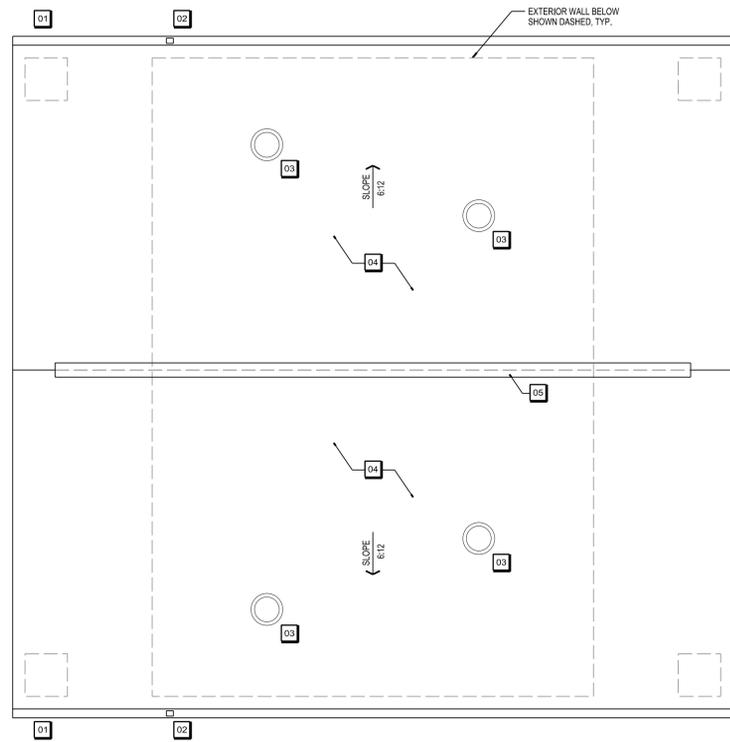


13 CONCESSIONS FLOOR PLAN
SCALE: 1/8" = 1'-0"


- GENERAL NOTES**
- SEE A301 FOR MATERIALS LEGEND.
 - MATERIALS OWNERSHIP UNLESS OTHERWISE INDICATED. DEMOLITION AND CONSTRUCTION WASTE BECOMES PROPERTY OF THE CONTRACTOR. REMOVE WASTE MATERIALS FROM PROJECT SITE AND DISPOSE OF THEM IN A LANDFILL ACCEPTABLE TO AUTHORITIES HAVING JURISDICTION. DO NOT ALLOW WASTE MATERIALS TO ACCUMULATE ON SITE. REMOVE AND TRANSPORT DEBRIS IN A MANNER THAT WILL PREVENT SPILLAGE ON ADJACENT SURFACES AND AREAS.
 - PROTECTION OF MASONRY: DURING CONSTRUCTION, COVER TOPS OF WALLS, PROJECTIONS, AND SILLS WITH WATERPROOF SHEETING AS END OF EACH WORK DAY. COVER PARTIALLY COMPLETED MASONRY WHEN CONSTRUCTION IS NOT IN PROGRESS.
 - GYPSUM BOARD SHALL BE MOLD-RESISTANT UNLESS OTHERWISE INDICATED.
- ROOF NOTES**
- PROVIDE WATER TIGHT INTEGRITY AT ALL PENETRATIONS & EQUIPMENT PER ROOFING MANUFACTURER'S STANDARD DETAILS & REQUIREMENTS FOR WARRANTY & CURRENT NRCA STANDARDS.
 - ROOF COVERING TO BE OF A CLASS A ROOF ASSEMBLY AND BY AN APPROVED TESTING AGENCY.
 - INSTALL ASPHALT SHINGLES IN ACCORDANCE WITH MANUFACTURER'S WRITTEN INSTRUCTIONS AND RECOMMENDATIONS IN NRCA'S NRCA GUIDELINE FOR ASPHALT SHINGLE ROOF SYSTEMS.
- KEYNOTES**
- 01** 5" METAL GUTTER 'OG' - STYLE.
 - 02** METAL DOWN SPOUT 4"x3".
 - 03** VELUX 14" DIA. SUN TUNNEL TUBULAR SKYLIGHT.
 - 04** ASPHALT SHINGLE OVER EXTERIOR GRADE WOOD SHEATHING w/ SYNTHETIC UNDERLAYMENT PER PLAN & MANUFACTURER'S RECOMMENDATIONS - WITH 25 YEAR WARRANTY.
 - 05** RIDGE VENT DETAIL - SEE 19/A601
 - 06** BABY CHANGING STATION - KOALA KARE, HORIZONTAL WALL MOUNTED.
 - 07** 24x24 MOP SINK
 - 08** WATER METER
 - 09** ELECTRICAL PANEL
 - 10** HOSE BIB
 - 11** FUTURE BEVERAGE COOLERS
 - 12** PLACE OF SALE AREA
 - 13** 30" DEEP SERVING COUNTER
 - 14** HAND WASHING SINK
 - 15** DASHED AREA TBD, POSSIBLE ICE CREAM OR ICE CHEST AND COUNTER / TABLE SPACE
 - 16** TOILET PARTITION TO BE TP1 AS SHOWN IN THE MATERIAL LEGEND ON SHEET A301
 - 17** 4" FLOOR DRAIN - CENTER BELOW TOILET PARTITION 4'-0" OFF 6" MASONRY WALL
 - 18** MASONRY BRICK FACADE - SCHEDULED ON A301 MATERIALS LIST AS BR1
 - 19** CAST STONE SILL - SCHEDULED ON A301 MATERIALS LIST AS ST1
 - 20** CEMENTITIOUS SMOOTH BOARD PANELS - SCHEDULED ON A301 MATERIAL LIST AS CWS1
 - 21** COMMERCIAL GRADE PRE-FINISHED METAL FACIA & SOFFIT - SCHEDULED ON A301 MATERIALS LIST AS MF1
 - 22** CEMENTITIOUS TRIM - TO MATCH COLOR SCHEDULED FOR CWS1
 - 23** CEMENTITIOUS BATTEN AT VERTICAL PANEL JOINTS - TO MATCH COLOR SCHEDULED FOR CWS1
 - 24** ELECTRICAL HAND DRYER

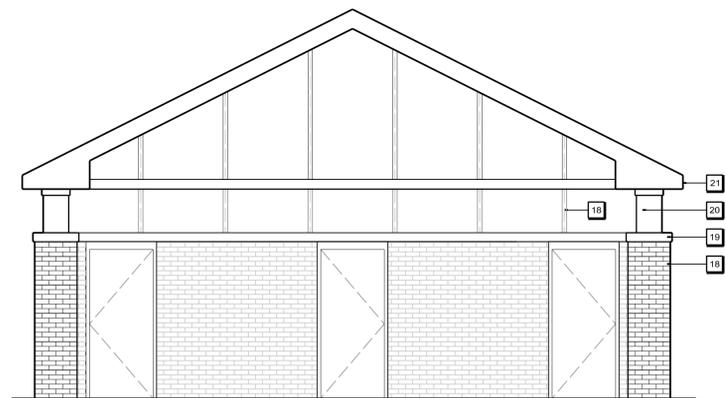

21 NORTHEAST ELEVATION
SCALE: 1/8" = 1'-0"

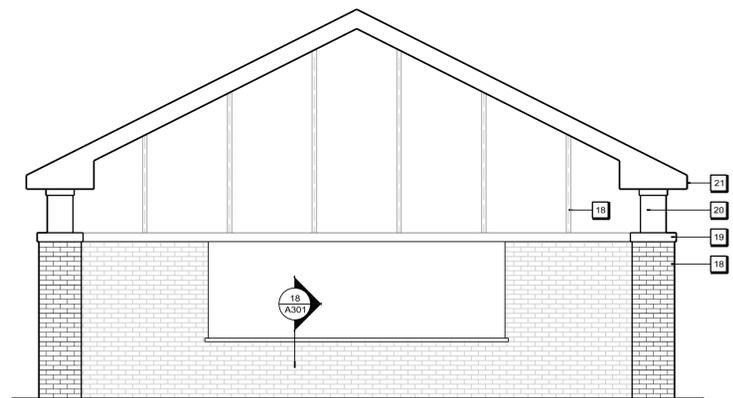

13 SOUTHWEST ELEVATION
SCALE: 1/8" = 1'-0"

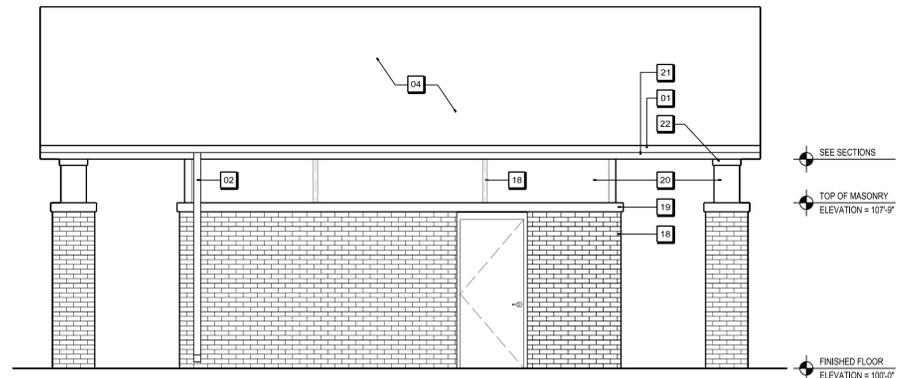

05 NORTHWEST / SOUTHEAST ELEVATIONS
SCALE: 1/8" = 1'-0"

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ISSUANCES	REVISIONS
STATE BUILDING REVIEW SUBMITTAL - 06/02/2020	

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**NEW PAVILION AND
SITE IMPROVEMENTS
THE GATHERING PLACE
MILTON, WI**

PROJECT NUMBER
67220
APPROVED BY
JUS
REVIEWED BY
JUS
DRAWN BY
TWA
6/12/2020 12:00:28 PM

CONCESSIONS PLANS AND
EXTERIOR ELEVATIONS


A101

STATE REVIEW DRAWINGS / CONSTRUCTION DOCUMENTS


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PLOTTED BY: STINNEY
ORIGINAL SIZE: 24" x 36"
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SCALE: 1/4"=1'-0"
 PLOTTED BY: STINNEY


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24
 A102
 SOUTHWEST ELEVATION
 SCALE: 1/8" = 1'-0"

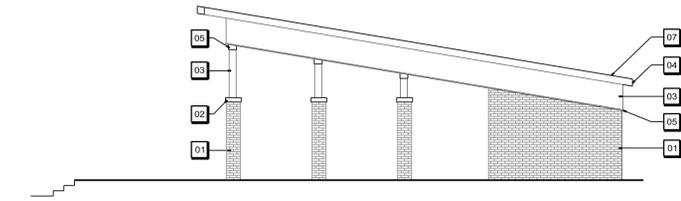

16
 A102
 SOUTHWEST ELEVATION
 SCALE: 1/8" = 1'-0"

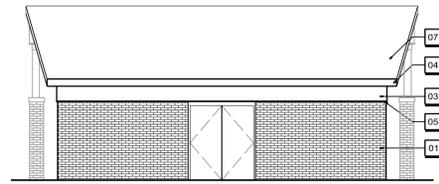

NORTH
 PAVILION FLOOR PLAN
 SCALE: 1/4"=1'-0"

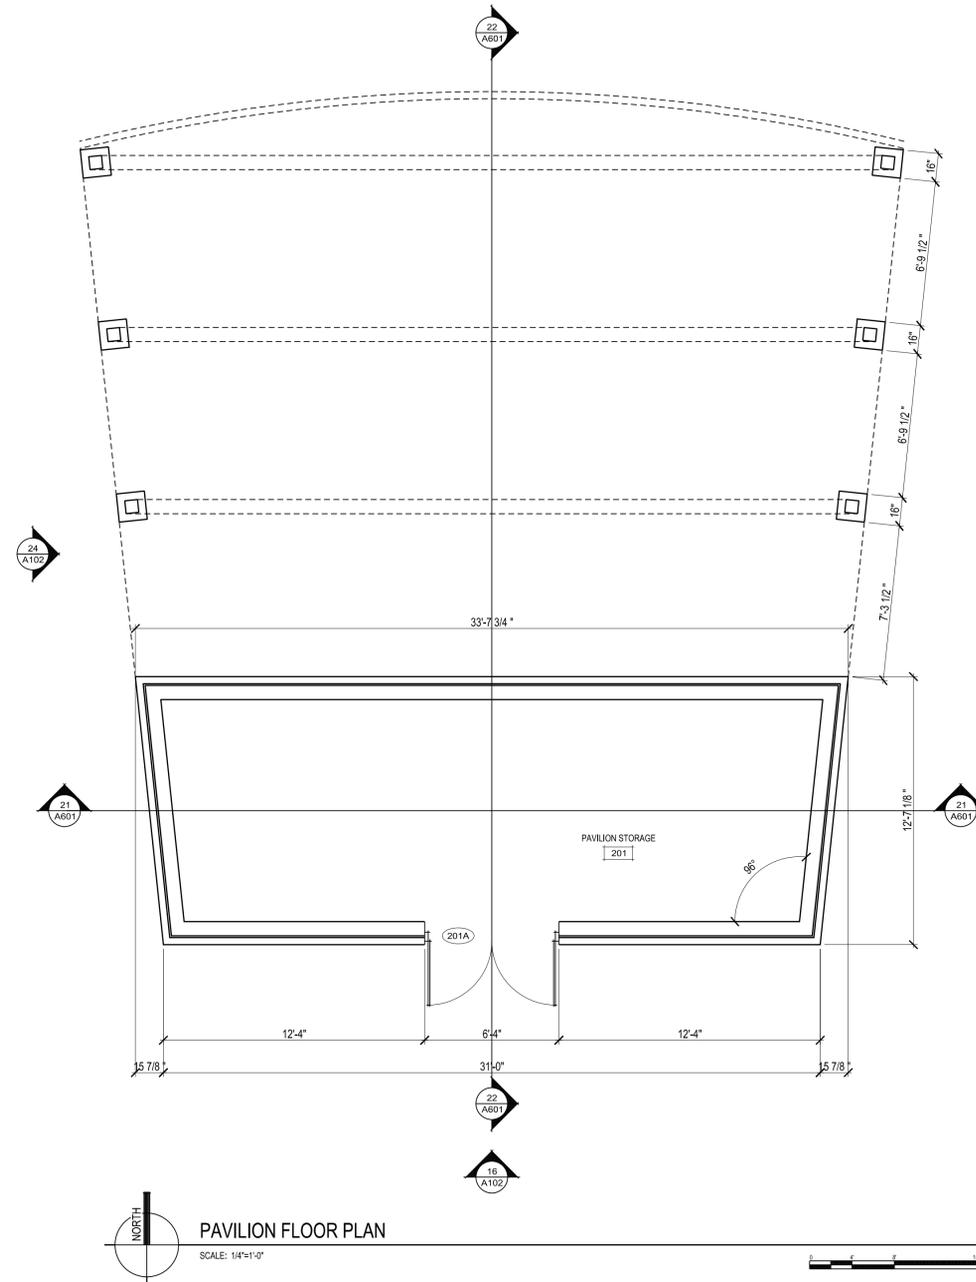- GENERAL NOTES**
- SEE A301 FOR MATERIALS LEGEND.
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 - ROOF COVERING TO BE OF A CLASS A ROOF ASSEMBLY AND BY AN APPROVED TESTING AGENCY.
 - INSTALL ASPHALT SHINGLES IN ACCORDANCE WITH MANUFACTURER'S WRITTEN INSTRUCTIONS AND RECOMMENDATIONS IN NRCA'S "NRCA GUIDELINE FOR ASPHALT SHINGLE ROOF SYSTEMS."
- KEYNOTES**
- 01 MASONRY BRICK FACADE - SCHEDULED ON A301 MATERIALS LIST AS BR1
 - 02 CAST STONE SILL - SCHEDULED ON A301 MATERIALS LIST AS ST1
 - 03 CEMENTITIOUS SMOOTH BOARD PANELS - SCHEDULED ON A301 MATERIAL LIST AS CWS1
 - 04 COMMERCIAL GRADE PRE-FINISHED METAL FACIA & SOFFIT - SCHEDULED ON A301 MATERIALS LIST AS MP1
 - 05 CEMENTITIOUS TRIM - TO MATCH COLOR SCHEDULED FOR CWS1
 - 06 CEMENTITIOUS BATTEN AT VERTICAL PANEL JOINTS - TO MATCH COLOR SCHEDULED FOR CWS1
 - 07 ASPHALT SHINGLED ROOFING

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ISSUANCES	REVISIONS
STATE BUILDING REVIEW SUBMITTAL - 06/02/2020	


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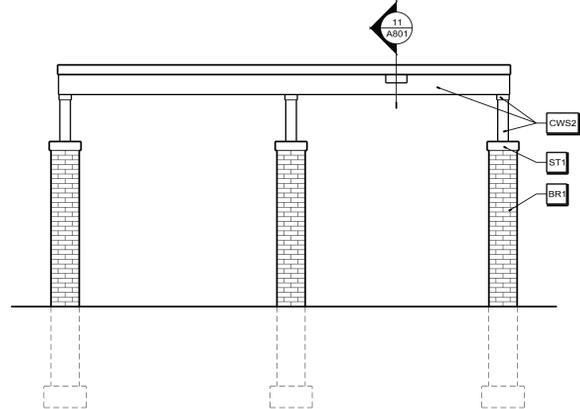
PROJECT NUMBER 6720	APPROVED BY JUS
REVIEWED BY JUS	DRAWN BY TWA
DATE 6/12/2020	TIME 12:00:52 PM

A102


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 PLOTTED BY: S Finney




22 CROSS SECTION
A103 SCALE: 3/4" = 1'-0"

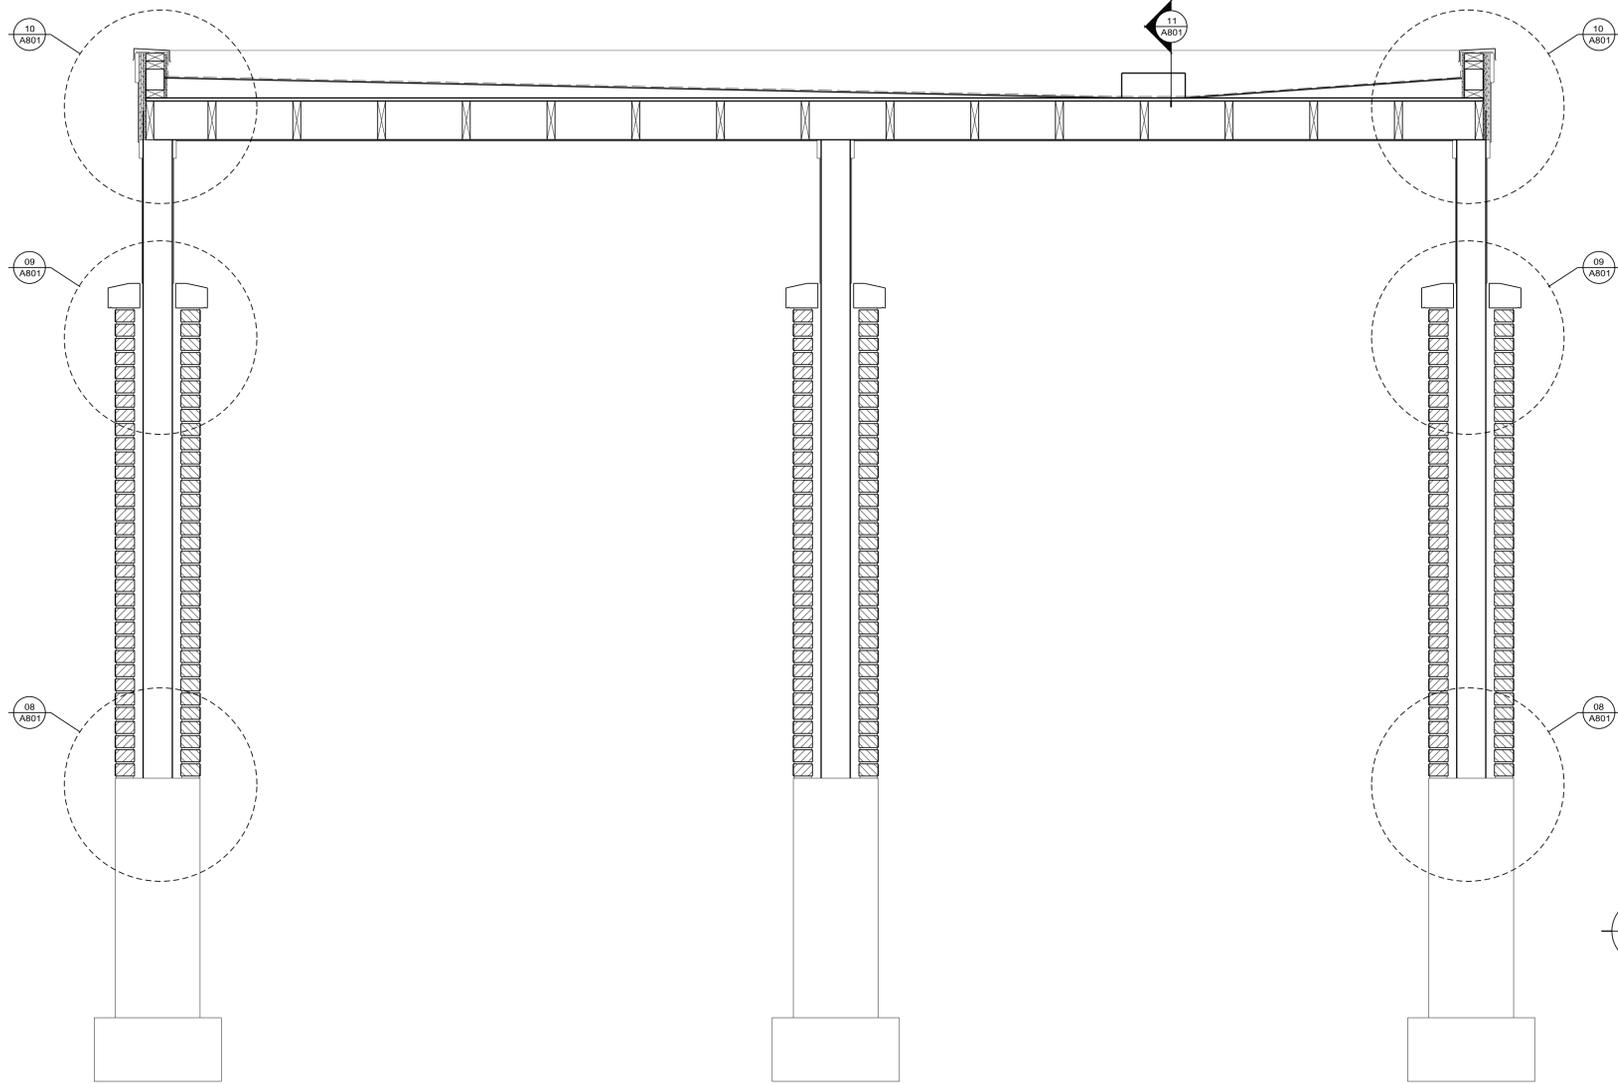


17 SIDE ELEVATION
A103 SCALE: 1/4" = 1'-0"

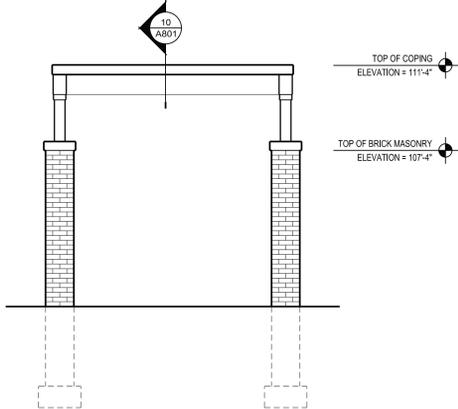

13 FRONT ELEVATION
A103 SCALE: 1/4" = 1'-0"

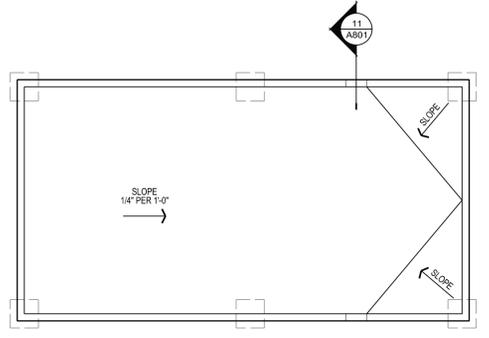

PERGOLA ROOF PLAN
 SCALE: 1/4" = 1'-0"

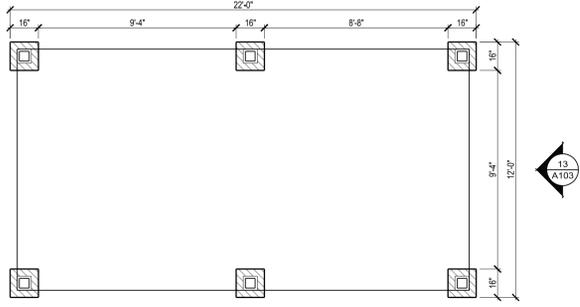

PERGOLA FLOOR PLAN
 SCALE: 1/4" = 1'-0"

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ISSUANCES	REVISIONS
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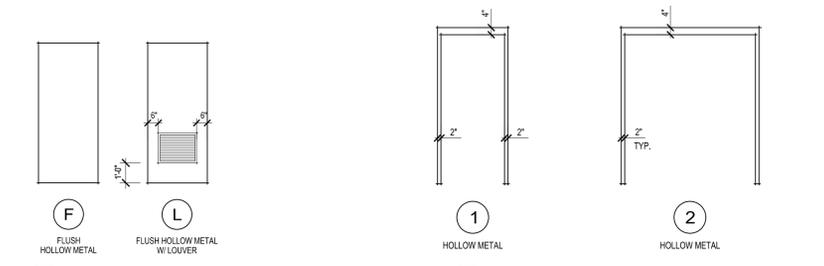
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**NEW PAVILION AND
 SITE IMPROVEMENTS
 THE GATHERING PLACE
 MILTON, WI**

PROJECT NUMBER
 6720
 APPROVED BY
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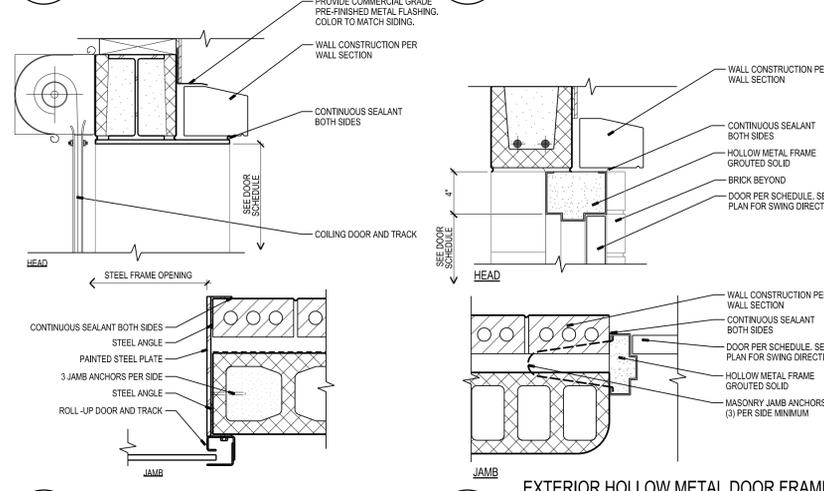
PAVILLION PLANS

A103




20 DOOR TYPES
 A301 SCALE: 1/4"=1'-0"

16 FRAME TYPES
 A301 SCALE: 1/4"=1'-0"



19 COILING DOOR HEAD AND JAMB DETAILS
 A301 SCALE: 1 1/2"=1'-0"

15 EXTERIOR HOLLOW METAL DOOR FRAME HEAD AND JAMB DETAILS AT CMU WALL
 A301 SCALE: 1 1/2"=1'-0"

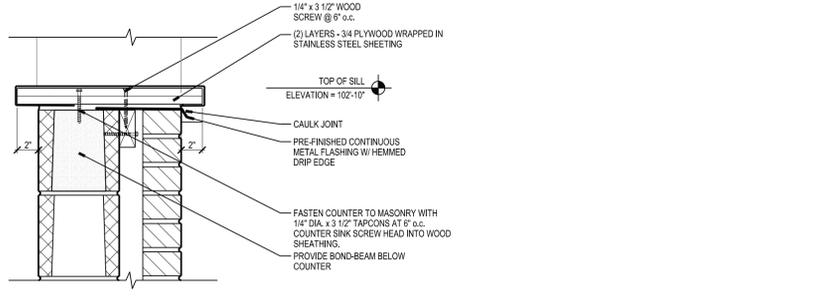

18 COILING DOOR SILL DETAIL
 A301 SCALE: 1 1/2"=1'-0"

DOOR SCHEDULE - FIRST FLOOR												
DOOR NUMBER	DOOR SIZE (WIDTH X HEIGHT)	FRAMES	DETAILS			HARDWARE				REMARKS		
			DOOR TYPE	BORROWED LITE TYPE	RATING / LABEL	HEAD	JAMB	HANGING DEVICE	SECURE DEVICE		EXIT DEVICE	CLOSE DEVICE
101	3'-0" x 7'-0"	1	L	-	15A301	15A301	HH	DB	-	CL	KP, P.LL, P.SP, THR, WTHR	GENERAL NOTES: 1. DOOR NUMBERS ARE DESIGNATED ON PLAN AS 100
102	3'-0" x 7'-0"	1	L	-	15A301	15A301	HH	DB	-	CL	KP, P.LL, P.SP, THR, WTHR	
103A	3'-0" x 7'-0"	1	F	-	15A301	15A301	HH	EN, DB	-	CL	THR, WTHR	
103B	3'-0" x 7'-0"	1	F	-	15A301	15A301	HH	EN, DB	-	CL	THR, WTHR	
103C	14'-0" x 4'-6"	-	-	-	19A301	19A301	-	-	-	-	-	
104	3'-0" x 7'-0"	1	F	-	15A301	15A301	HH	ST, DB	-	CL	KP, THR, WTHR	BASIS OF DESIGN OVERHEAD DOOR COMPANY, MANUAL PUSH-UP OPERATION, CLEAR ANODIZED ALUMINUM FINISH
201A	PR - 3'-0" x 7'-0"	2	F	-	15A301	15A301	HH	EN, DB	-	CL	DC, THR, WTHR	

HARDWARE LEGEND

HG HINGE - GEAR (CONTINUOUS) TYPE
 HH HINGE - HEAVY WEIGHT BALL BEARING

SECURING DEVICES:
 DB DEADBOLT, DOUBLE CYLINDER
 EN LOCKSET, ENTRANCE FUNCTION
 ST LOCKSET, STOREROOM FUNCTION

EXIT DEVICES:
 ERE RIM, ENTRANCE FUNCTION

CLOSING DEVICES:
 CL OVERHEAD EXPOSED WITH HOLD-OPEN

MISCELLANEOUS HARDWARE ITEMS:
 DC DRIP CAP
 KP KICK PLATES
 P.LL PULL BAR
 P.SP PUSH BAR
 P.SP PUSH PLATE
 THR THRESHOLD
 WTHR WEATHERSTRIPPING, INCLUDING BOTTOM SWEEP

DOOR AND FRAME NOTES

-DELIVER HOLLOW-METAL DOORS AND FRAMES PALLETIZED, PACKAGED, OR CRATED TO PROVIDE PROTECTION DURING TRANSIT AND PROJECT-SITE STORAGE. DO NOT USE NONVENTED PLASTIC.

EXTRA-HEAVY-DUTY DOORS AND FRAMES: ANSISDI A250.8, LEVEL 3, ANSISDI A250.4, LEVEL A.
 -FACE: METALLIC-COATED STEEL SHEET, MINIMUM THICKNESS OF 0.053 INCH, WITH MINIMUM A40 COATING.
 -EDGE CONSTRUCTION: MODEL 1, FULL FLUSH.
 -EDGE BEVEL: PROVIDE MANUFACTURER'S STANDARD BEVELED OR SQUARED EDGES.
 -TOP EDGE CLOSURES: CLOSE TOP EDGES OF DOORS WITH FLUSH CLOSURES OF SAME MATERIAL AS FACE SHEETS. SEAL JOINTS AGAINST WATER PENETRATION.
 -BOTTOM EDGES: CLOSE BOTTOM EDGES OF DOORS WITH END CLOSURES OR CHANNELS OF SAME MATERIAL AS FACE SHEETS. PROVIDE WEEP-HOLE OPENINGS IN BOTTOMS OF EXTERIOR DOORS TO PERMIT MOISTURE TO ESCAPE.
 -CORE: MANUFACTURER'S STANDARD.
 -FRAME CONSTRUCTION: FACE WELDED.

-EXPOSED FINISH: FACTORY.
 -FACTORY FINISH: CLEAN, PRETREAT, AND APPLY MANUFACTURER'S STANDARD TWO-COAT, BAKED-ON FINISH CONSISTING OF PRIME COAT AND THERMOSETTING TOPCOAT, COMPLYING WITH ANSISDI A250.3.

-INSTALL HOLLOW METAL DOORS AND FRAMES PLUMB, RIGID, PROPERLY ALIGNED, AND SECURELY FASTENED IN PLACE. COMPLY WITH APPROVED SHOP DRAWINGS AND WITH MANUFACTURER'S WRITTEN INSTRUCTIONS.

-INSTALLING HOLLOW-METAL FRAMES: COMPLY WITH ANSISDI A250.1.1.

-INSTALLING HOLLOW-METAL DOORS: COMPLY WITH ANSISDI A250.8.

ROOM FINISH SCHEDULE - FIRST FLOOR						
NO.	ROOM NAME	FLOOR	BASE	WALLS	CEILING	
	LEGEND					
	ENTIRE ROOM	FLOOR TILE	BASE	WALLS	CEILING	
	NORTH	PAK-OFF CARPET TILE	WOOD	PAINTED (P)	EXPOSED STRUCTURE	
	SOUTH	SEALED CONCRETE (SC)	W/VP 8" PORCELAIN TILE (CT3)	ACCENT PAINT	GYPSUM (GP)	
	EAST	EXISTING	WOOD	WOOD PANEL ACCENT	EXISTING	
	WEST	EXISTING	WOOD	WOOD PANEL ACCENT	EXISTING	
101	WOMEN'S					CEILING TO BE 8'-0" A.F.F.
102	MEN'S					CEILING TO BE 8'-0" A.F.F.
103	CONCESSIONS					CEILING TO BE 8'-0" A.F.F.
201	PAVILION STORAGE					CEILING HEIGHT VARIES

MATERIALS LEGEND					
CODE	MATERIAL	MANUFACTURER	PRODUCT NUMBER	DESCRIPTION	REMARKS
P1	PAINT	BENJAMIN MOORE	NATURA INTERIOR SEMI-GLOSS	MPI#54	1 COAT ULTRA SPEC BLOCK FILLER PRIMER AND 2 COATS FINISH COLOR: GREYISH SW # 6001
BR1	BRICK	-	-	-	-
SC1	SEALED CONCRETE	BENJAMIN MOORE	INSUL-X TUFFCRETE SOLVENT ACRYLIC CONCRETE SEALER	MPI#58	COLOR: CLEAR HIGH GLOSS
ST1	STONE CAP	EDWARDS CAST STONE	E303	STONE SILL	COLOR: TBD
TP1	TOILET PARTITION	SCRANTON PRODUCTS	HINY HIDERS PARTITIONS	FLOOR MOUNTED OVERHEAD BRACED	COLOR: TBD TEXTURE: ORANGE PEEL
CWS1	CEMENTITIOUS WOOD SIDING	JAMES HARDE	VERTICAL SIDING	CEDAR MILL	COLOR: TBD
CWS2	CEMENTITIOUS WOOD SIDING	JAMES HARDE	SIDING	SMOOTH	COLOR: TBD
MF1	METAL FASCIA AND SOFFIT	PAC-CLAD	-	-	COLOR: TBD
GP1	GYPSUM BOARD	-	-	MOLD-RESISTANT	PAINT: NATURA INTERIOR SEMI-GLOSS WITH 2 COATS FINISH COLOR: GREYISH SW # 6001

MATERIALS LEGEND NOTES

-VERTICAL SIDING TO HAVE 2-1/2" VERTICAL BATTENS AT 4'-0" o.c. IN GABLE ENDS AND 8'-0" o.c. ALONG THE EAVE SIDE OF THE BUILDING. HORIZONTAL JOINTS TO BE CAULKED PER MANUFACTURER'S DETAILS.

-APPLY PAINTS ONLY WHEN TEMPERATURE OF SURFACES TO BE PAINTED AND AMBIENT AIR TEMPERATURES ARE BETWEEN 50 AND 95 DEG. F. DO NOT APPLY PAINTS WHEN RELATIVE HUMIDITY EXCEEDS 85 PERCENT; AT TEMPERATURES LESS THAN 50 DEG. F. ABOVE THE DREW POINT; OR TO DAMP OR WET SURFACES.


-COMPLY WITH MANUFACTURER'S WRITTEN INSTRUCTIONS AND RECOMMENDATIONS IN "MPI ARCHITECTURAL PAINTING SPECIFICATIONS MANUAL," APPLICABLE TO SUBSTRATES AND PAINT SYSTEMS INDICATED.

-APPLY PAINTS ACCORDING TO MANUFACTURER'S WRITTEN INSTRUCTIONS AND TO RECOMMENDATIONS IN "MPI MANUAL."

-MOLD-RESISTANT GYPSUM BOARD: ASTM C1396/C1396M. WITH MOISTURE- AND MOLD-RESISTANT CORE AND PAPER SURFACES.
 -CORE: 5/8 INCH, TYPE X.
 -LONG EDGES: TAPERED.
 -MOLD RESISTANCE: ASTM D3273. SCORE OF 10 AS RATED ACCORDING TO ASTM D3274.

-INSTALLING GYPSUM BOARD:
 -COMPLY WITH ASTM C840.
 -INSTALL CEILING PANELS ACROSS FRAMING TO MINIMIZE THE NUMBER OF ABUTTING END JOINTS AND TO AVOID ABUTTING END JOINTS IN CENTRAL AREA OF EACH CEILING. STAGGER ABUTTING END JOINTS OF ADJACENT PANELS NOT LESS THAN ONE FRAMING MEMBER.

-GYPSUM BOARD FINISH LEVELS: FINISH PANELS TO LEVELS INDICATED AND ACCORDING TO ASTM C840.
 -LEVEL 4: AT PANEL SURFACES THAT WILL BE EXPOSED TO VIEW UNLESS OTHERWISE INDICATED.

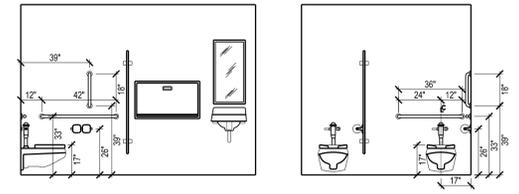

05 RESTROOM INTERIOR ELEVATION
 A301 SCALE: 1/4"=1'-0"

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PROJECT NUMBER: 67220
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 REVIEWED BY: JUS
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ISSUANCES
 STATE BUILDING REVIEW SUBMITTAL - 06/02/2020

REVISIONS

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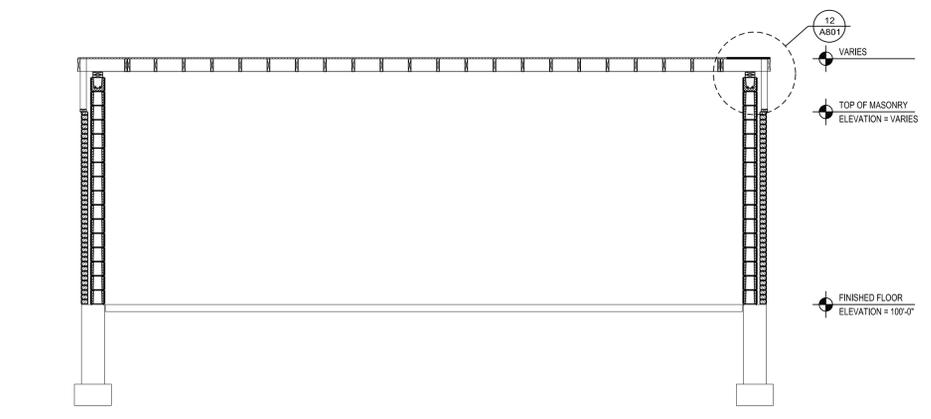
NEW PAVILION AND SITE IMPROVEMENTS
 THE GATHERING PLACE
 MILTON, WI

CONCESSIONS
 INTERIOR ELEVATIONS
 LINE 3
 LINE 4
A301


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SCALE: 1/8"=1'-0"
 PLOTTED BY: S. Finney


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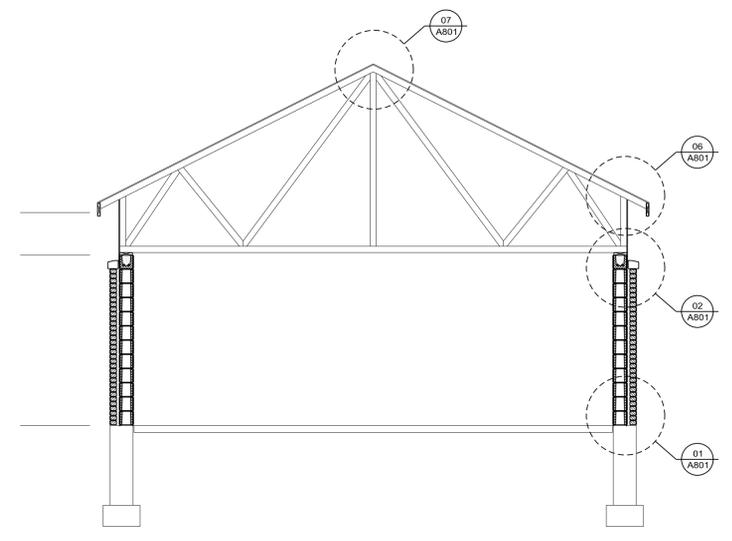
23 PAVILION BUILDING SECTION
 A601 SCALE: 1/4" = 1'-0"



11 BUILDING SECTION
 A601 SCALE: 1/4" = 1'-0"

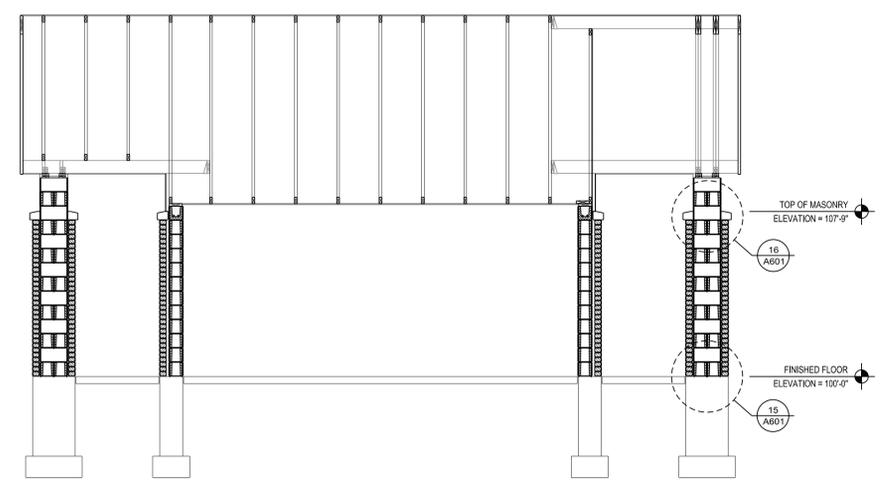

21 PAVILION BUILDING SECTION
 A601 SCALE: 1/4" = 1'-0"

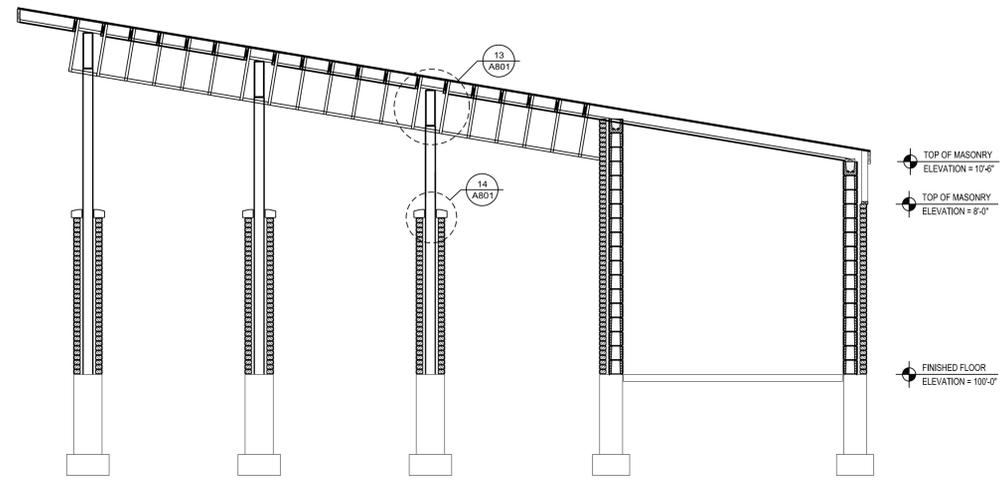

09 BUILDING SECTION
 A601 SCALE: 1/4" = 1'-0"

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**NEW PAVILION AND
 SITE IMPROVEMENTS
 THE GATHERING PLACE
 MILTON, WI**

PROJECT NUMBER	6720
APPROVED BY	JJS
REVIEWED BY	JJS
DRAWN BY	A/YA
DATE	6/12/2020 12:02:53 PM


BUILDING SECTIONS

A601


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SCALE: 1/8"=1'-0"
PLOTTED BY: Stinney


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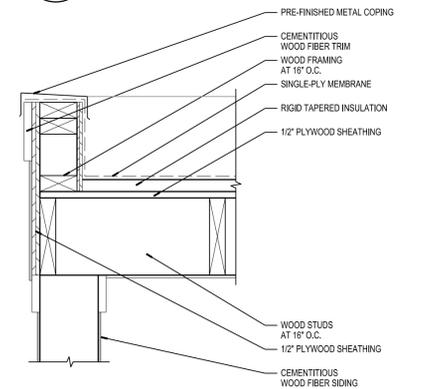
13 PAVILLION DETAIL
A801 SCALE: 3/4"=1'-0"

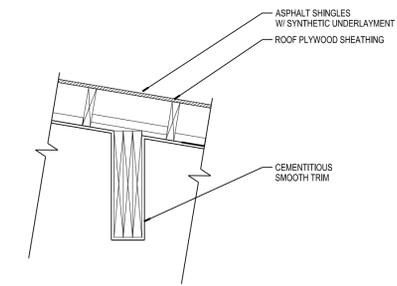


14 PAVILLION DETAIL
A801 SCALE: 1 1/2"=1'-0"

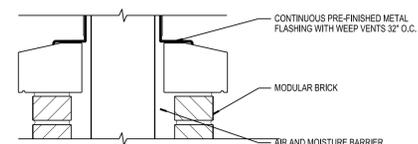


09 STONE CAP DETAIL
A801 SCALE: 1 1/2"=1'-0"

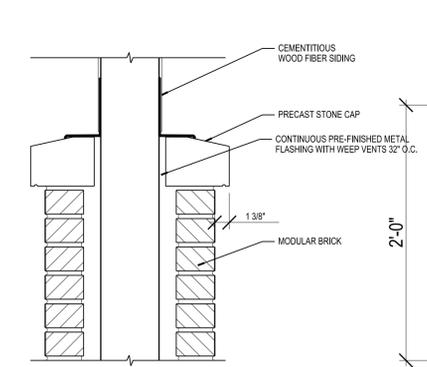


10 ROOF EDGE DETAIL
A801 SCALE: 1 1/2"=1'-0"

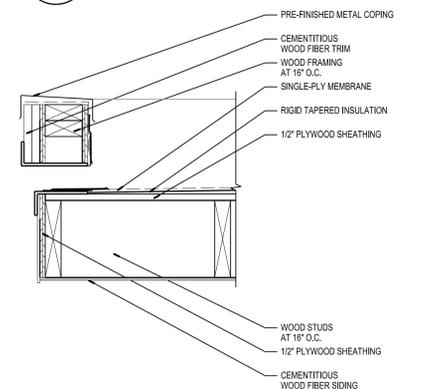


11 ROOF EDGE DETAIL
A801 SCALE: 1 1/2"=1'-0"

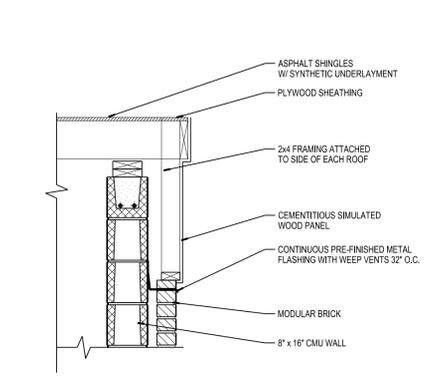


12 PAVILLION DETAIL
A801 SCALE: 3/4"=1'-0"

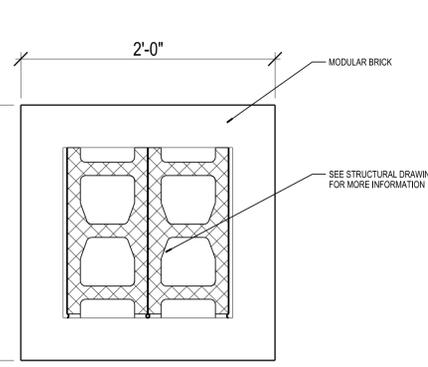


05 COLUMN DETAIL
A801 SCALE: 1 1/2"=1'-0"

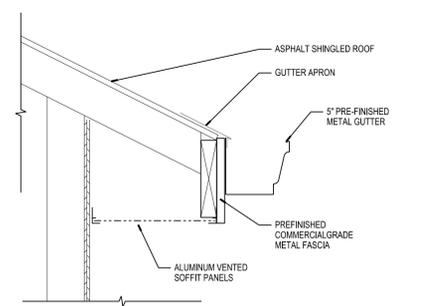


06 DETAIL AT ROOF
A801 SCALE: 1 1/2"=1'-0"

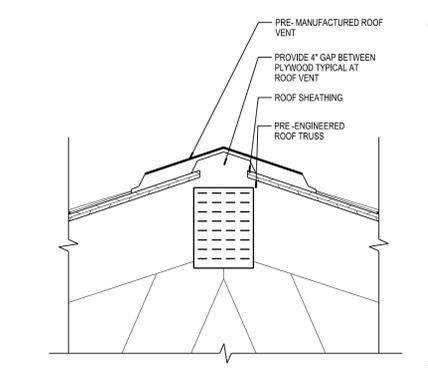


07 RIDGE VENT DETAIL
A801 SCALE: 1 1/2"=1'-0"

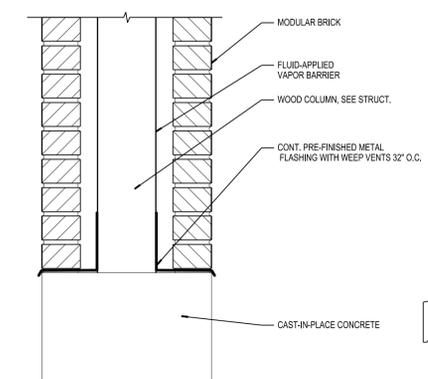


08 PERGOLA DETAIL
A801 SCALE: 1 1/2"=1'-0"

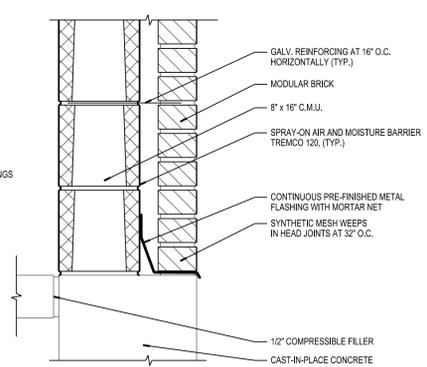


01 WALL DETAIL
A801 SCALE: 1 1/2"=1'-0"

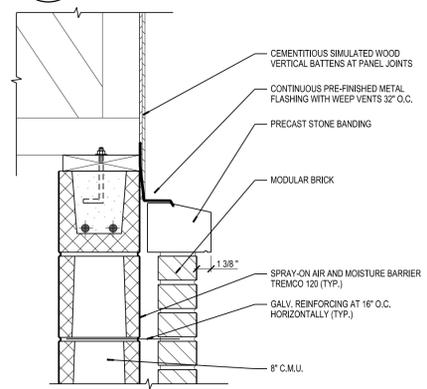

02 WALL DETAIL
A801 SCALE: 1 1/2"=1'-0"

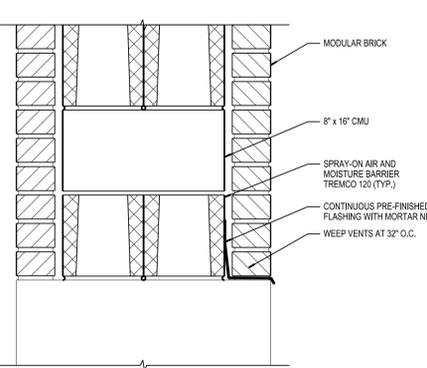

03 COLUMN BASE DETAIL
A801 SCALE: 1 1/2"=1'-0"

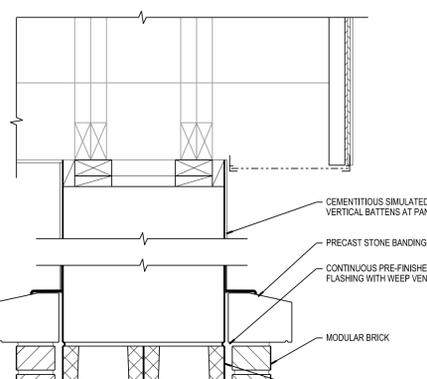

16 WALL DETAIL
A601 SCALE: 1 1/2"=1'-0"

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NEW PAVILLION AND
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THE GATHERING PLACE
MILTON, WI

PROJECT NUMBER: 67220
APPROVED BY: JUS
REVIEWED BY: JUS
DRAWN BY: JUS

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DETAILS
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